LYCÉE FRANÇAIS AUDITORIUM IMPROVEMENTS

1201 ORTEGA ST, SAN FRANCISCO, CA 94122

PROJECT SCOPE **GENERAL NOTES ABBREVIATIONS** DRAWING INDEX ALL WORK AND MATERIALS SHALL BE IN ACCORDANCE WITH THE APPLICABLE FEDERAL. MINOR IMPROVEMENTS TO (E) AUDITORIUM AT LYCÉE FRANÇAIS. NO CHANGE TO BUILDING EXTERIOR. COVER SHEET STATE AND/OR LOCAL CODES, LAWS, ORDINANCES, STATUTES AND REGULATIONS, AND IMPROVEMENTS INCLUDE - (N) SOUND BOOTH, LIMITED CARPET & UPHOLSTERY REPLACEMENT, ADDITIONAL A.F.F. ABOVE FINISH FLOOR WITH INDUSTRY ASSOCIATIONS' REQUIREMENTS, AND MANUFACTURER'S REQUIREMENTS **ARCHITECTURAL** THEATRICAL LIGHTING & (N) AV EQUIPMENT BD. B.O. BOARD BOTTOM OF AND RECOMMENDATIONS, NOTHING IN THE DRAWINGS IS TO BE CONSTRUED AS REQUIRING OR PERMITTING WORK CONTRARY TO THESE APPLICABLE RULES, PROJECT DESCRIPTION DEMOLITION PLAN REGULATIONS, REQUIREMENTS, AND CODES. CALIFORNIA BUILDING CODE REFLECTED CEILING DEMOLITION PLAN CONTRACTOR FURNISHED CONTRACTOR INSTALLED LYCÉE FRANÇAIS IS A FRENCH MULTICULTURAL AND BILINGUAL SCHOOL, PRE-K THROUGH 12TH GRADE WITH VARIOUS BAY THESE NOTES ARE INTENDED AS A GUIDE TO THE CONSTRUCTION REQUIREMENTS FLOOR PLAN AREA LOCATIONS. THE ORTEGA CAMPUS HOUSES GRADES 6 -12 AND THE 340 SEAT AUDITORIUM - THÉÂTRE DU LYCÉE REFLECTED CEILING PLAN ESTABLISHED FOR THIS PROJECT, NO CONTRACTOR SHOULD ATTEMPT TO DESIGN. BID. OR CLEAR INTERIOR ELEVATIONS CONSTRUCT ANY PORTION OF THE WORK HEREIN WITHOUT FULL UNDERSTANDING OF THE CONCRETE DESIGN INTENT AND APPLICABLE CODE REQUIREMENTS. THE CONTRACTOR SHOULD CONTINUOUS OBTAIN CLARIFICATION FROM THE ARCHITECT IF HE IS UNCERTAIN OF DESIGN INTENT. PROJECT DATA PRODUCTION LIGHTING DEMOLISH / DEMOLITION DIMENSION THE DESIGN PRESENTED ON THESE DRAWINGS ESTABLISHES THE GENERAL DIM D.S. DWG. LIGHTING PLAN ARCHITECTURAL REQUIREMENTS FOR THE PROJECT. IT DOES NOT PRESENT ALL DETAILS DOWNSPOUT REQUIRED FOR CONSTRUCTION, THE CONTRACTOR IS EXPECTED TO EXERCISE SOUND. JUDGEMENT IN ACCORDANCE WITH CODE REQUIREMENTS. FAST ASSESSOR PARCEL NUMBER: 2115037 **ELECTRICAL (DESIGN-BUILD) EXISTING** THE DRAWINGS INDICATE LOCATION, DIMENSIONS, AND TYPICAL DETAILS OF CONSTRUCTION FEATURES OF CONSTRUCTION SHOWN ARE TYPICAL AND APPLY ELECTRICAL **ELECTRICAL NOTES AND SCHEDULES** GENERALLY FOR SIMILAR CONDITIONS. THE DRAWINGS DO NOT ILLUSTRATE EVERY EQ. EXT. FOLIAL ELECTRICAL SINGLE-LINE DIAGRAM OCCUPANCY CLASSIFICATION: 'A1' - AUDITORIUM WITH FIXED SEATING **EXTERIOR** CONDITION. IN THE EVENT THAT CERTAIN FEATURES ARE NOT FULLY SHOWN ON THE **ELECTRICAL PLAN PARTIAL 1ST FLOOF** CONSTRUCTION TYPE REINFORCED CONCRETE, FIRE-RESISTANT DRAWINGS OR CALLED FOR IN THE SPECIFICATIONS, THEIR CONSTRUCTION SHALL BE (A) ELECTRICAL PLAN PARTIAL 2ND FLOOR FINISH FLOOR OF THE SAME CHARACTER AS SHOWN FOR SIMILAR CONDITIONS OR (B) IN ACCORD WITH NUMBER OF STORIES 2 STORIED BUILDING FACE OF CONVENTIONAL PRACTICES OF THE CBC OR (C) AS CLARIFIED BY THE ARCHITECT, WHERE DISCREPANCIES OCCUR. THEY THEY SHALL BE REPORTED TO THE ARCHITECT FOR GYPSUM GALVANIZED SHEET METAL BUII DING HEIGHT +/- 34 FT (NO CHANGE) NUMBER OF STORIES 2 (NO CHANGE) **HEIGHT** NO ONE DRAWING OR SPECIFICATION SECTION SHALL "GOVERN". CONTRACTOR SHALL SPRINKLER SYSTEM (E) AUTOMATIC SPRINKLER SYSTEM THROUGHOUT CORRELATE WORK AMONG ALL DRAWINGS AND SPECIFICATIONS, AND ALSO BETWEEN INFORMATION DRAWINGS OF DIFFERENT SCALES WITHIN EACH SECTION IT IS THE EXPLICIT AND SPECIFIC INTERIOR AREA CALCULATIONS: AUDITORIUM BUILDING AREA - 5000 SQ FT (NO CHANGE) RESPONSIBILITY OF THE CONTRACTOR TO EXAMINE THE CONTRACT DOCUMENTS IN THEIR MANUFACTURER MINIMUM ENTIRETY, REPORT ALL DISCREPANCIES ENCOUNTERED THEREIN TO THE ARCHITECT AND TENANT OCCUPANT LOAD: 418 OCCUPANTS AWAIT RESOLUTION BEFORE PROCEEDING WITH ANY WORK AFFECTED BY SUCH MOUNTED PARKING: PARKING ON SITE UNLESS SHOWN OTHERWISE, DETAILS SHOWN AS "TYPICAL" APPLY WHEREVER APPROPRIATE. SPECIFIC DETAILS TAKE PRECEDENCE OVER "TYPICAL" DETAILS. SPECIFIC NOT IN CONTRACT NOTES ON DRAWINGS TAKE PRECEDENCE OVER GENERAL NOTES. NOT TO SCALE DIMENSIONS MARKED "VERIFY" ARE TO BE CHECKED FOR ACCURACY BY THE CONTRACTOR ON CENTER OCCUPANT LOAD LOCATION MAP \bigoplus PROJECT ROSTER AND ALL DISCREPANCIES ARE TO BE BROUGHT TO THE THE ATTENTION OF THE ARCHITECT **OPPOSITE** OWNER FURNISHED **OWNER OWNER'S REPRESENTATIVE** DO NOT SCALE THE DRAWINGS. LAY OUT WORK FOLLOWING WRITTEN DIMENSIONS. IF CONTRACTOR INSTALLED WRITTEN DIMENSIONS ARE LACKING. NOTIFY THE ARCHITECT AT ONCE, WHERE PROJECT SITE LYCEE FRANCAIS WATERSHED PARTNERS INC. PLYWOOD DISCREPANCIES OCCUR, THEY SHALL BE REPORTED TO THE ARCHITECT FOR RESOLUTION PHONE: (617)-733-1778 SAN FRANCISCO, CA 94122 REFLECTED DIMENSIONS ARE GIVEN TO FACE OF FINISH UNLESS OTHERWISE NOTED ON THE ATTN: KELLY PATTERSON REQ'D REQUIRED ARCHITECT LIGHTING DESIGN THE CONTRACTOR SHALL BE DEEMED TO HAVE INSPECTED THE SITE AND VERIFY ACTUAL MARCY WONG DONN LOGAN ARCHITECTS MINUSCULE LIGHTING DESIGN SCHED. SCHEDULE GRADES, ELEVATIONS, DIMENSIONS, AND DECLINATIONS AND THE TRUE CONDITIONS 1260 MASONIC AVE #2 800 BANCROFT WAY, SUITE 200 SF SIM. UNDER WHICH WORK IS TO BE PERFORMED. ANY DISCREPANCIES SHALL BE CALLED TO SIMIL AR SAN FRANCISCO, CA, 94117 BERKELEY, CALIFORNIA 94710 THE ATTENTION OF THE ARCHITECT BEFORE PROCEEDING WITH THE WORK. PHONE: 415.322.0629 PHONE: (510) 843-0916 TOP OF EMAIL: max@minuscule.lighting ALL CONDITIONS AFFECTING WORK PROGRESS AND CONFORMANCE TO PLANS AND EMAIL: donn@wonglogan.com TYPICAL SPECIFICATIONS SHALL BE VERIFIED BY THE CONTRACTOR PRIOR TO START OF WORK ATTN: DONN LOGAN ATTN: MAX PIERSON-LIÉNARD UNLESS OTHERWISE NOTED **ELECTRICAL CONTRACTOR** ANY SITE AND BUILDING AREAS UNAFFECTED BY THIS WORK SHALL BE PROTECTED FROM V.I.F. VERIFY IN FIELD ANY DAMAGE CAUSED BY THIS WORK, ANY DAMAGE TO EXISTING STRUCTURES AND CORISH ELECTRIC BUILDING ELEMENTS SO CALLED SHALL BE THE FINANCIAL RESPONSIBILITY OF THE P.O BOX 812. MILLBRAE, CA 94030 PHONE: 415.626.1885 THE CONTRACTOR SHALL PATCH ALL AREAS OF EXISTING BUILDING WHICH ARE IN NEED O **DEFERRED SUBMITTALS** APPLICABLE CODES SUCH WORK AS A RESULT OF DEMOLITION, INSTALLATION OF NEW ITEMS, OR NEW 2016 BUILDING STANDARDS ADMINISTRATIVE CODE ANY WASTE AND REFUSE CAUSED BY THIS WORK SHALL BE REMOVED FROM THE 2016 CALIFORNIA BUILDING CODE ELECTRICAL CHANGES TO COORDINATE WITH IMPROVEMENT TO BE PREMISES AND DISPOSED OF BY CONTRACTOR IN A LEGAL MANNER 2016 CALIFORNIA ELECTRICAL CODE DESIGN-BUILD UNDER SEPERATE PERMIT. CONTRACTOR TO OBTAIN PERMIT 2016 CALIFORNIA MECHANICAL CODE AND PAY REQUIRED FEES. ALL DEFERRED SUBMITTALS MUST BE REVIEWED INFORMATION SHOWN IN DRAWINGS REGARDING EXISTING CONSTRUCTION IS 2016 CALIFORNIA PLUMBING CODE AND APPROVED BY MARCY WONG DONN LOGAN ARCHITECTS PRIOR TO

BEING SUBMITTED FOR PERMIT.

APPROXIMATE. CONTRACTOR SHALL SURVEY EXISTING CONDITIONS AND VERIFY DETAILED

SHALL BE CALLED TO THE ATTENTION OF THE ARCHITECT BEFORE PROCEEDING WITH THE

CHARACTERISTICS AFFECTING THE WORK OF THIS CONTRACT. ANY DISCREPANCIES

2016 CALIFORNIA ENERGY CODE

2016 DEPARTMENT OF JUSTICE ADA STANDARDS FOR

2016 CALIFORNIA FIRE CODE

MARCY WONG DONN LOGAN

800 bancroft way #200 berkeley. ca 94710 office@wonglogan.com tel. 510. 843.0916




LYCÉE **FRANÇAIS**


1201 ORTEGA ST, SAN FRANCISCO, CA 94122


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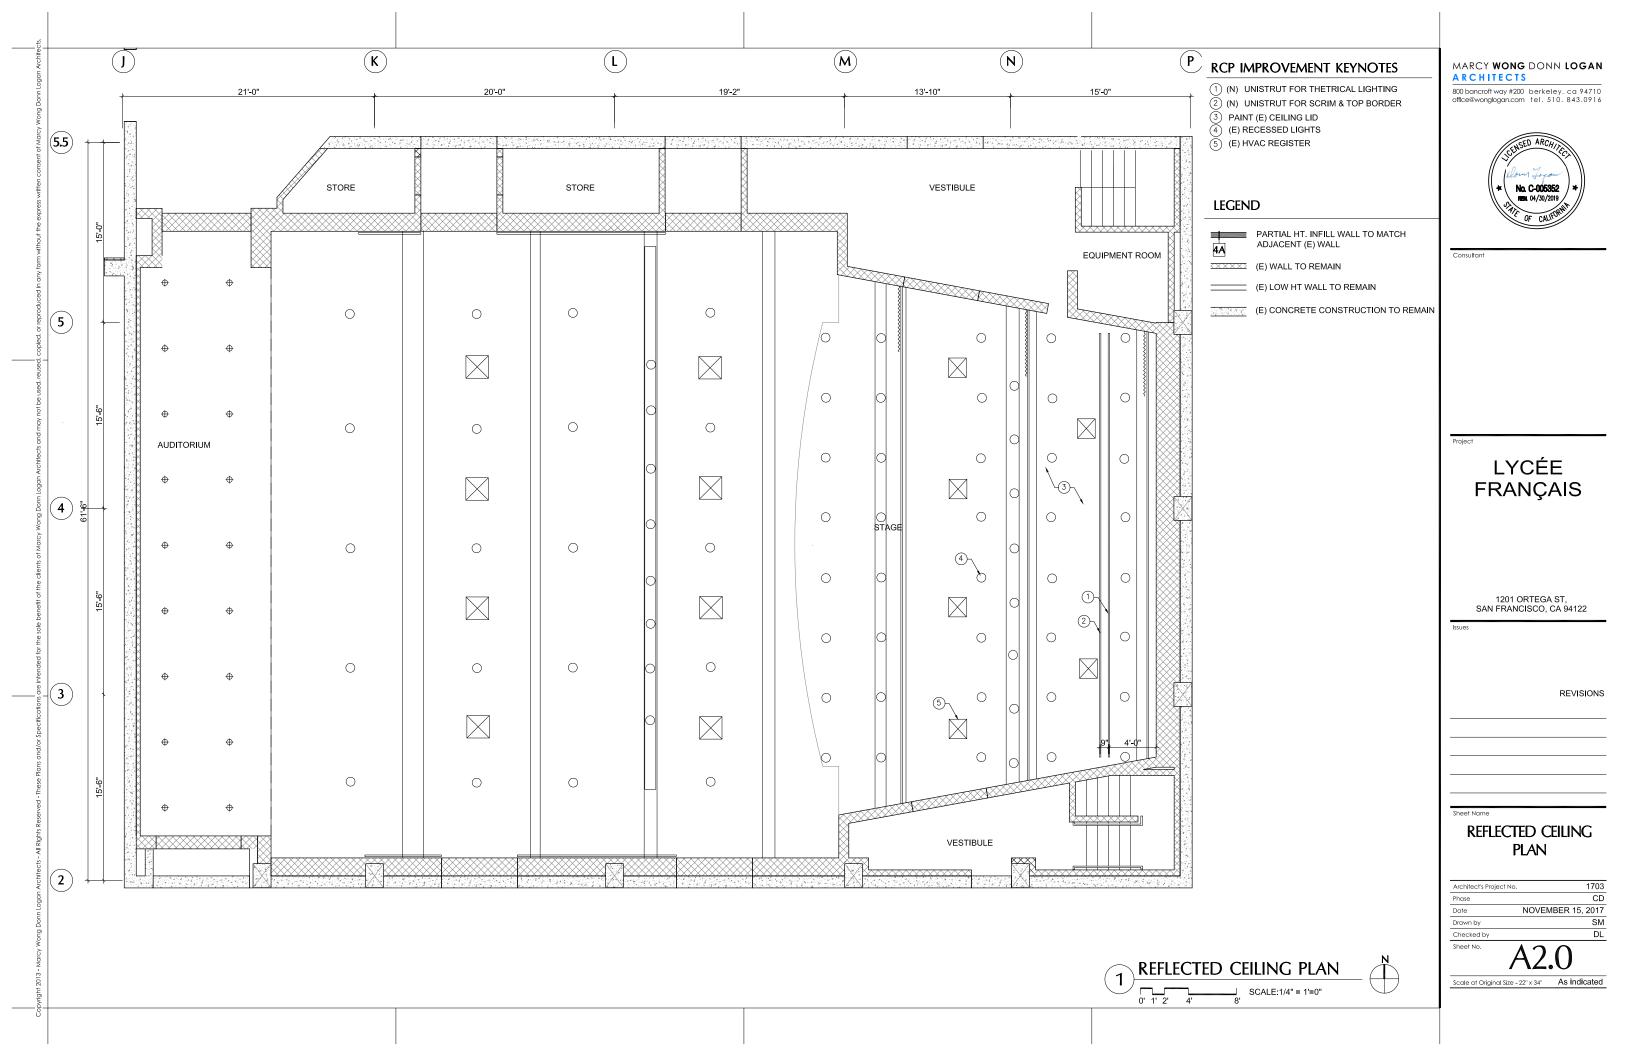
COVER SHEET


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Drawn by	SM
Date	DECEMBER 7, 2017
Phase	CE
Architect's Project No	o. 1703



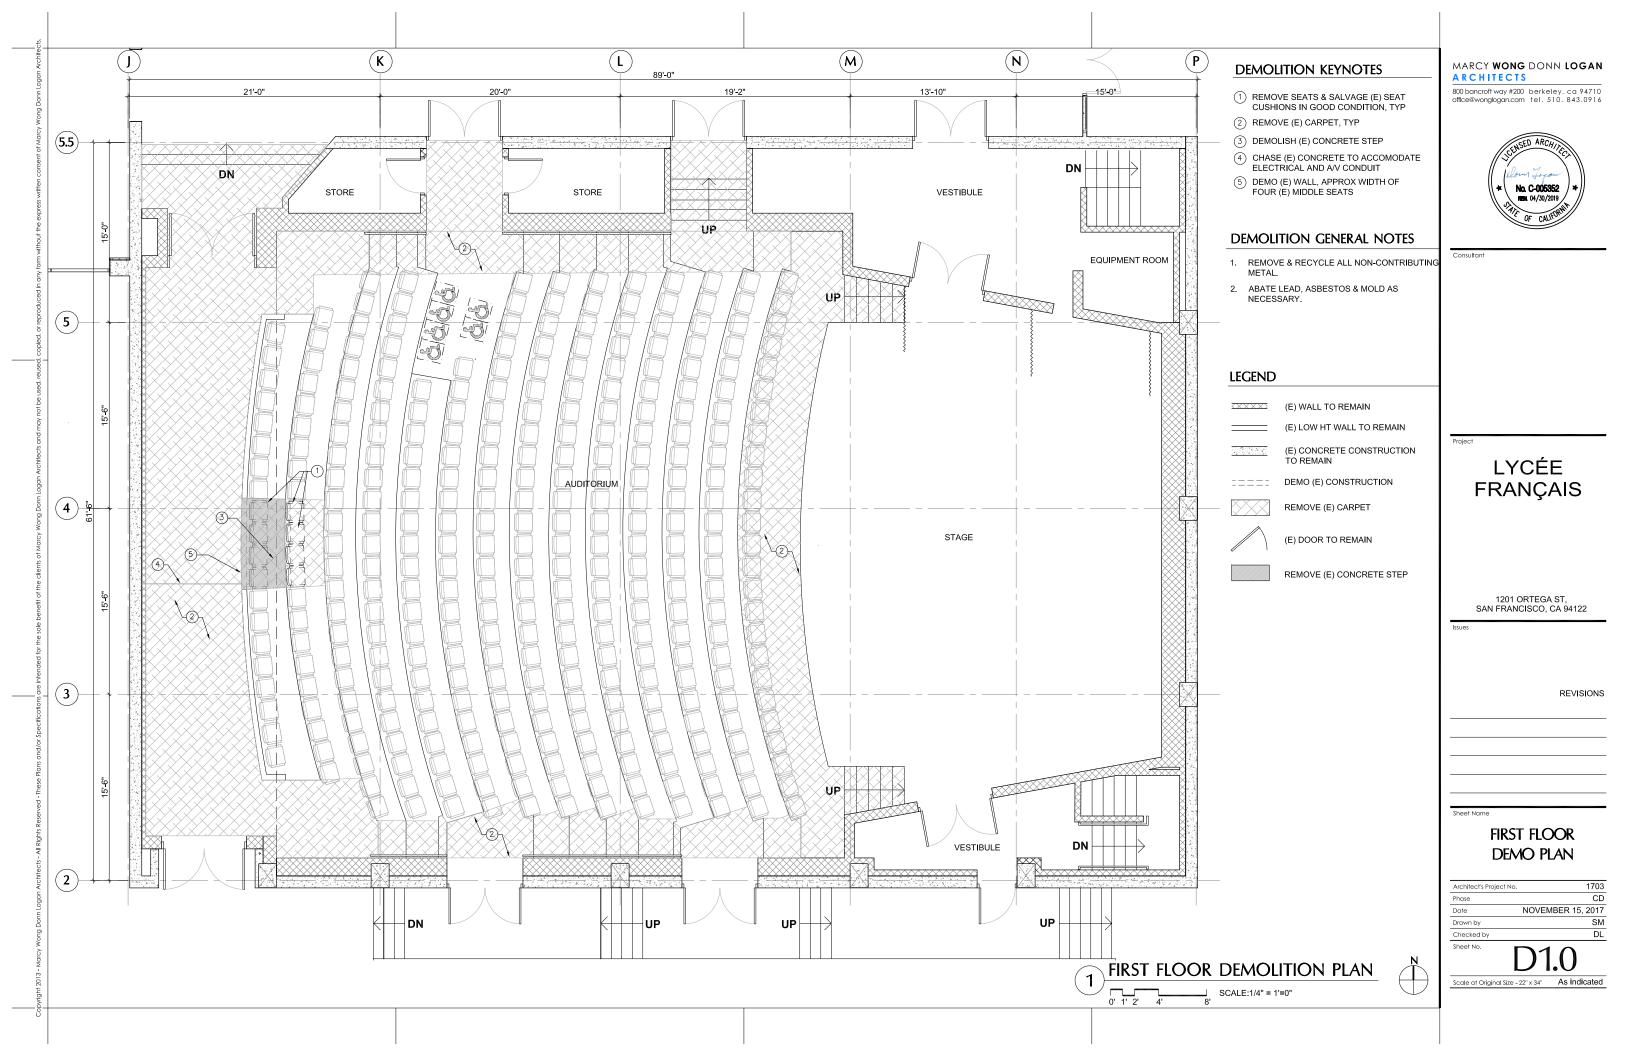

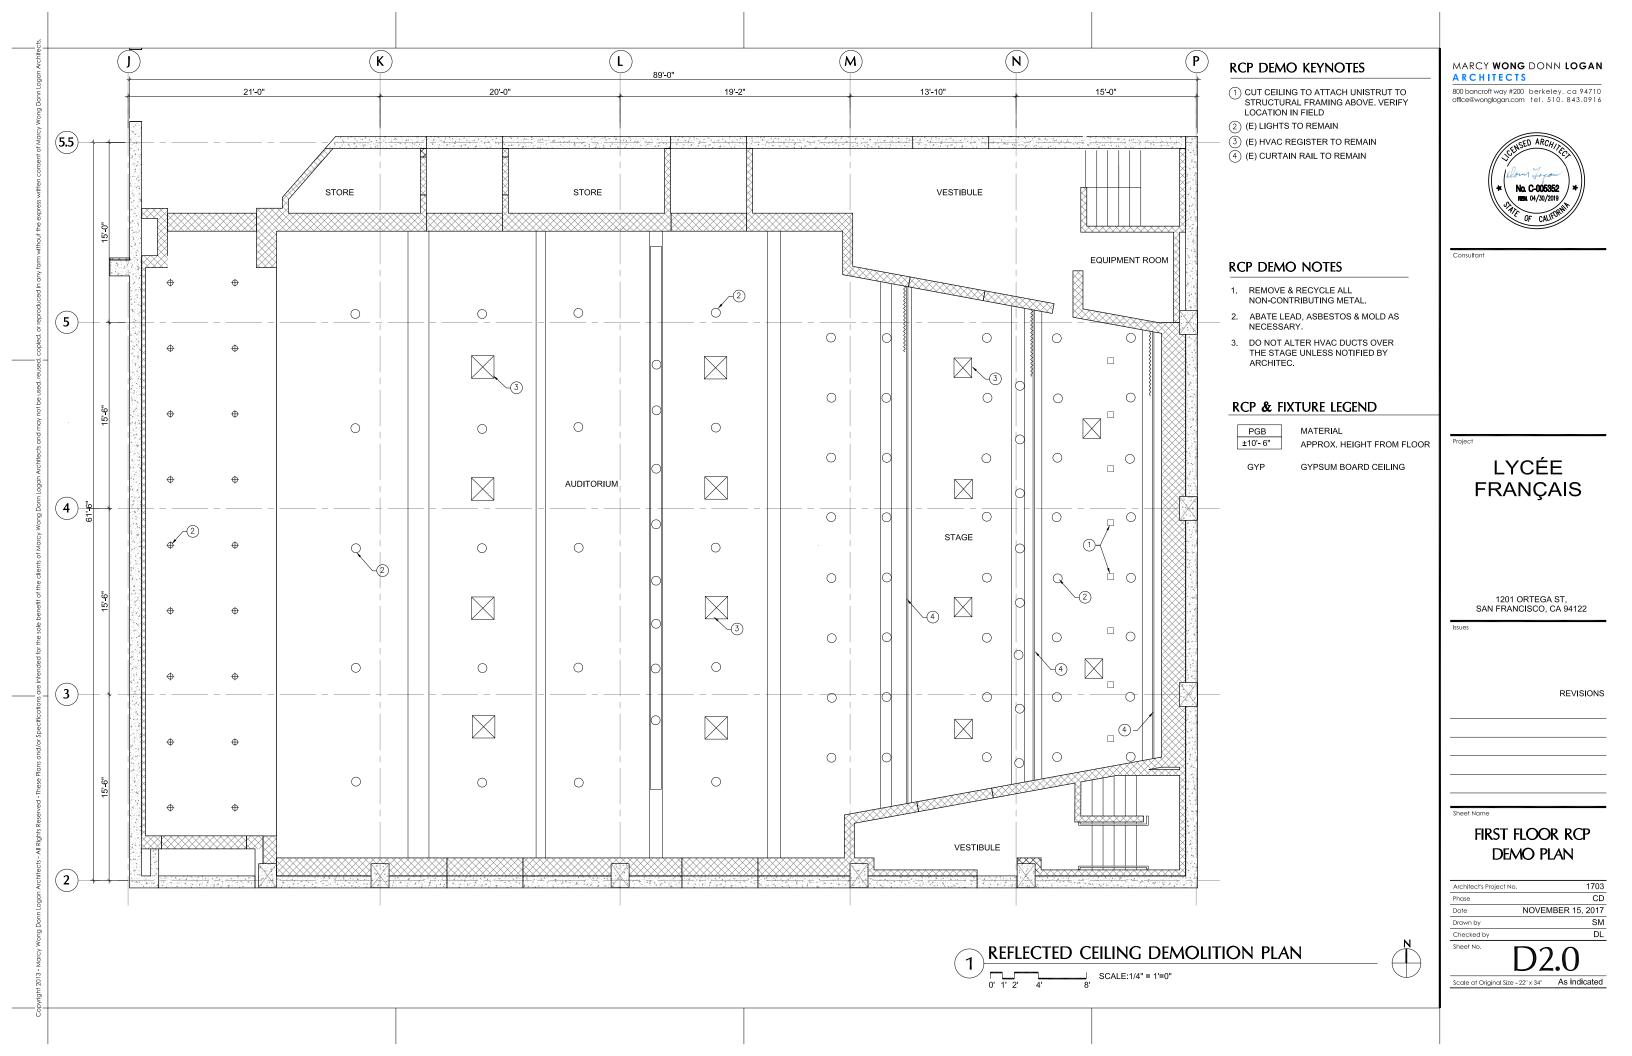

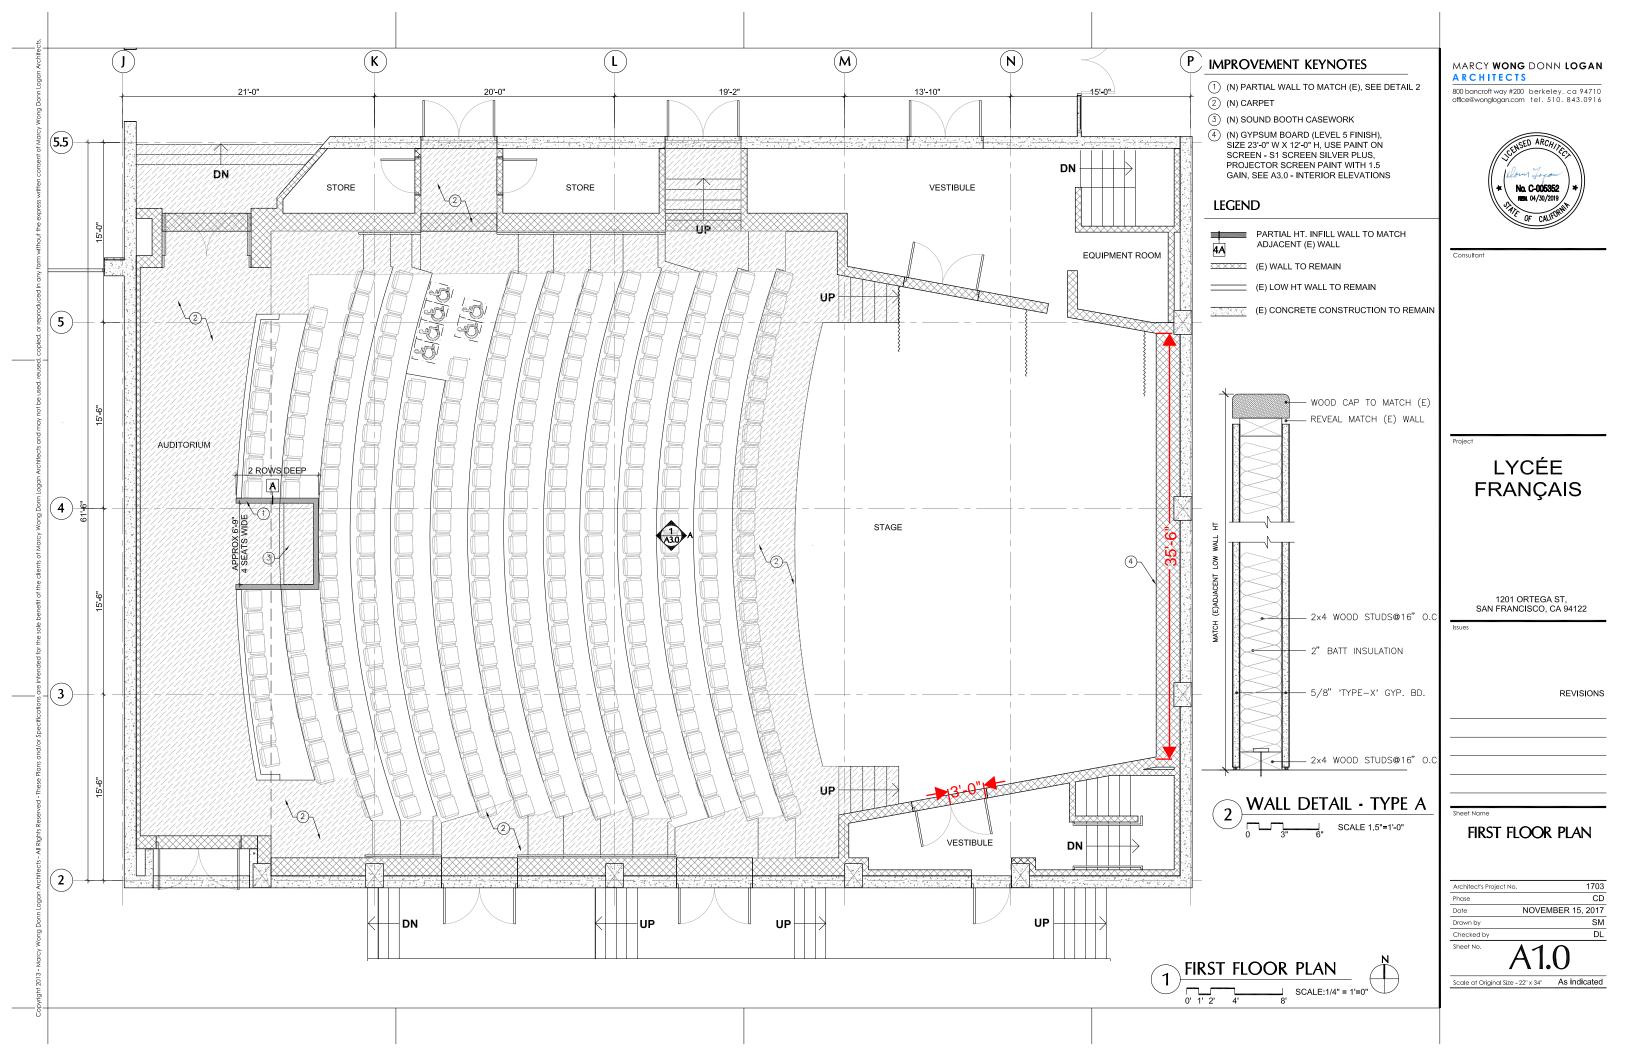

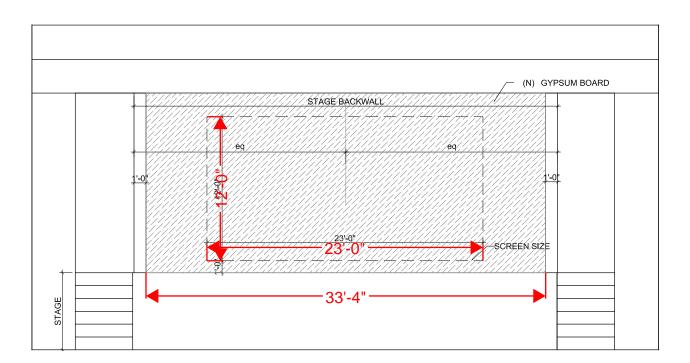



MARCY WONG DONN LOGAN ARCHITECTS

800 bancroft way #200 berkeley. ca 94710 office@wonglogan.com tel. 510. 843.0916



Consu

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LYCÉE FRANÇAIS

1201 ORTEGA ST, SAN FRANCISCO, CA 94122


Issues

REVISIONS

INTERIOR ELEVATIONS

Sheet No.	43.0
Checked by	DL
Drawn by	SM
Date	NOVEMBER 15, 2017
Phase	CD
Architect's Project No.	1703

Scale at Original Size - 22" x 34" As indicated

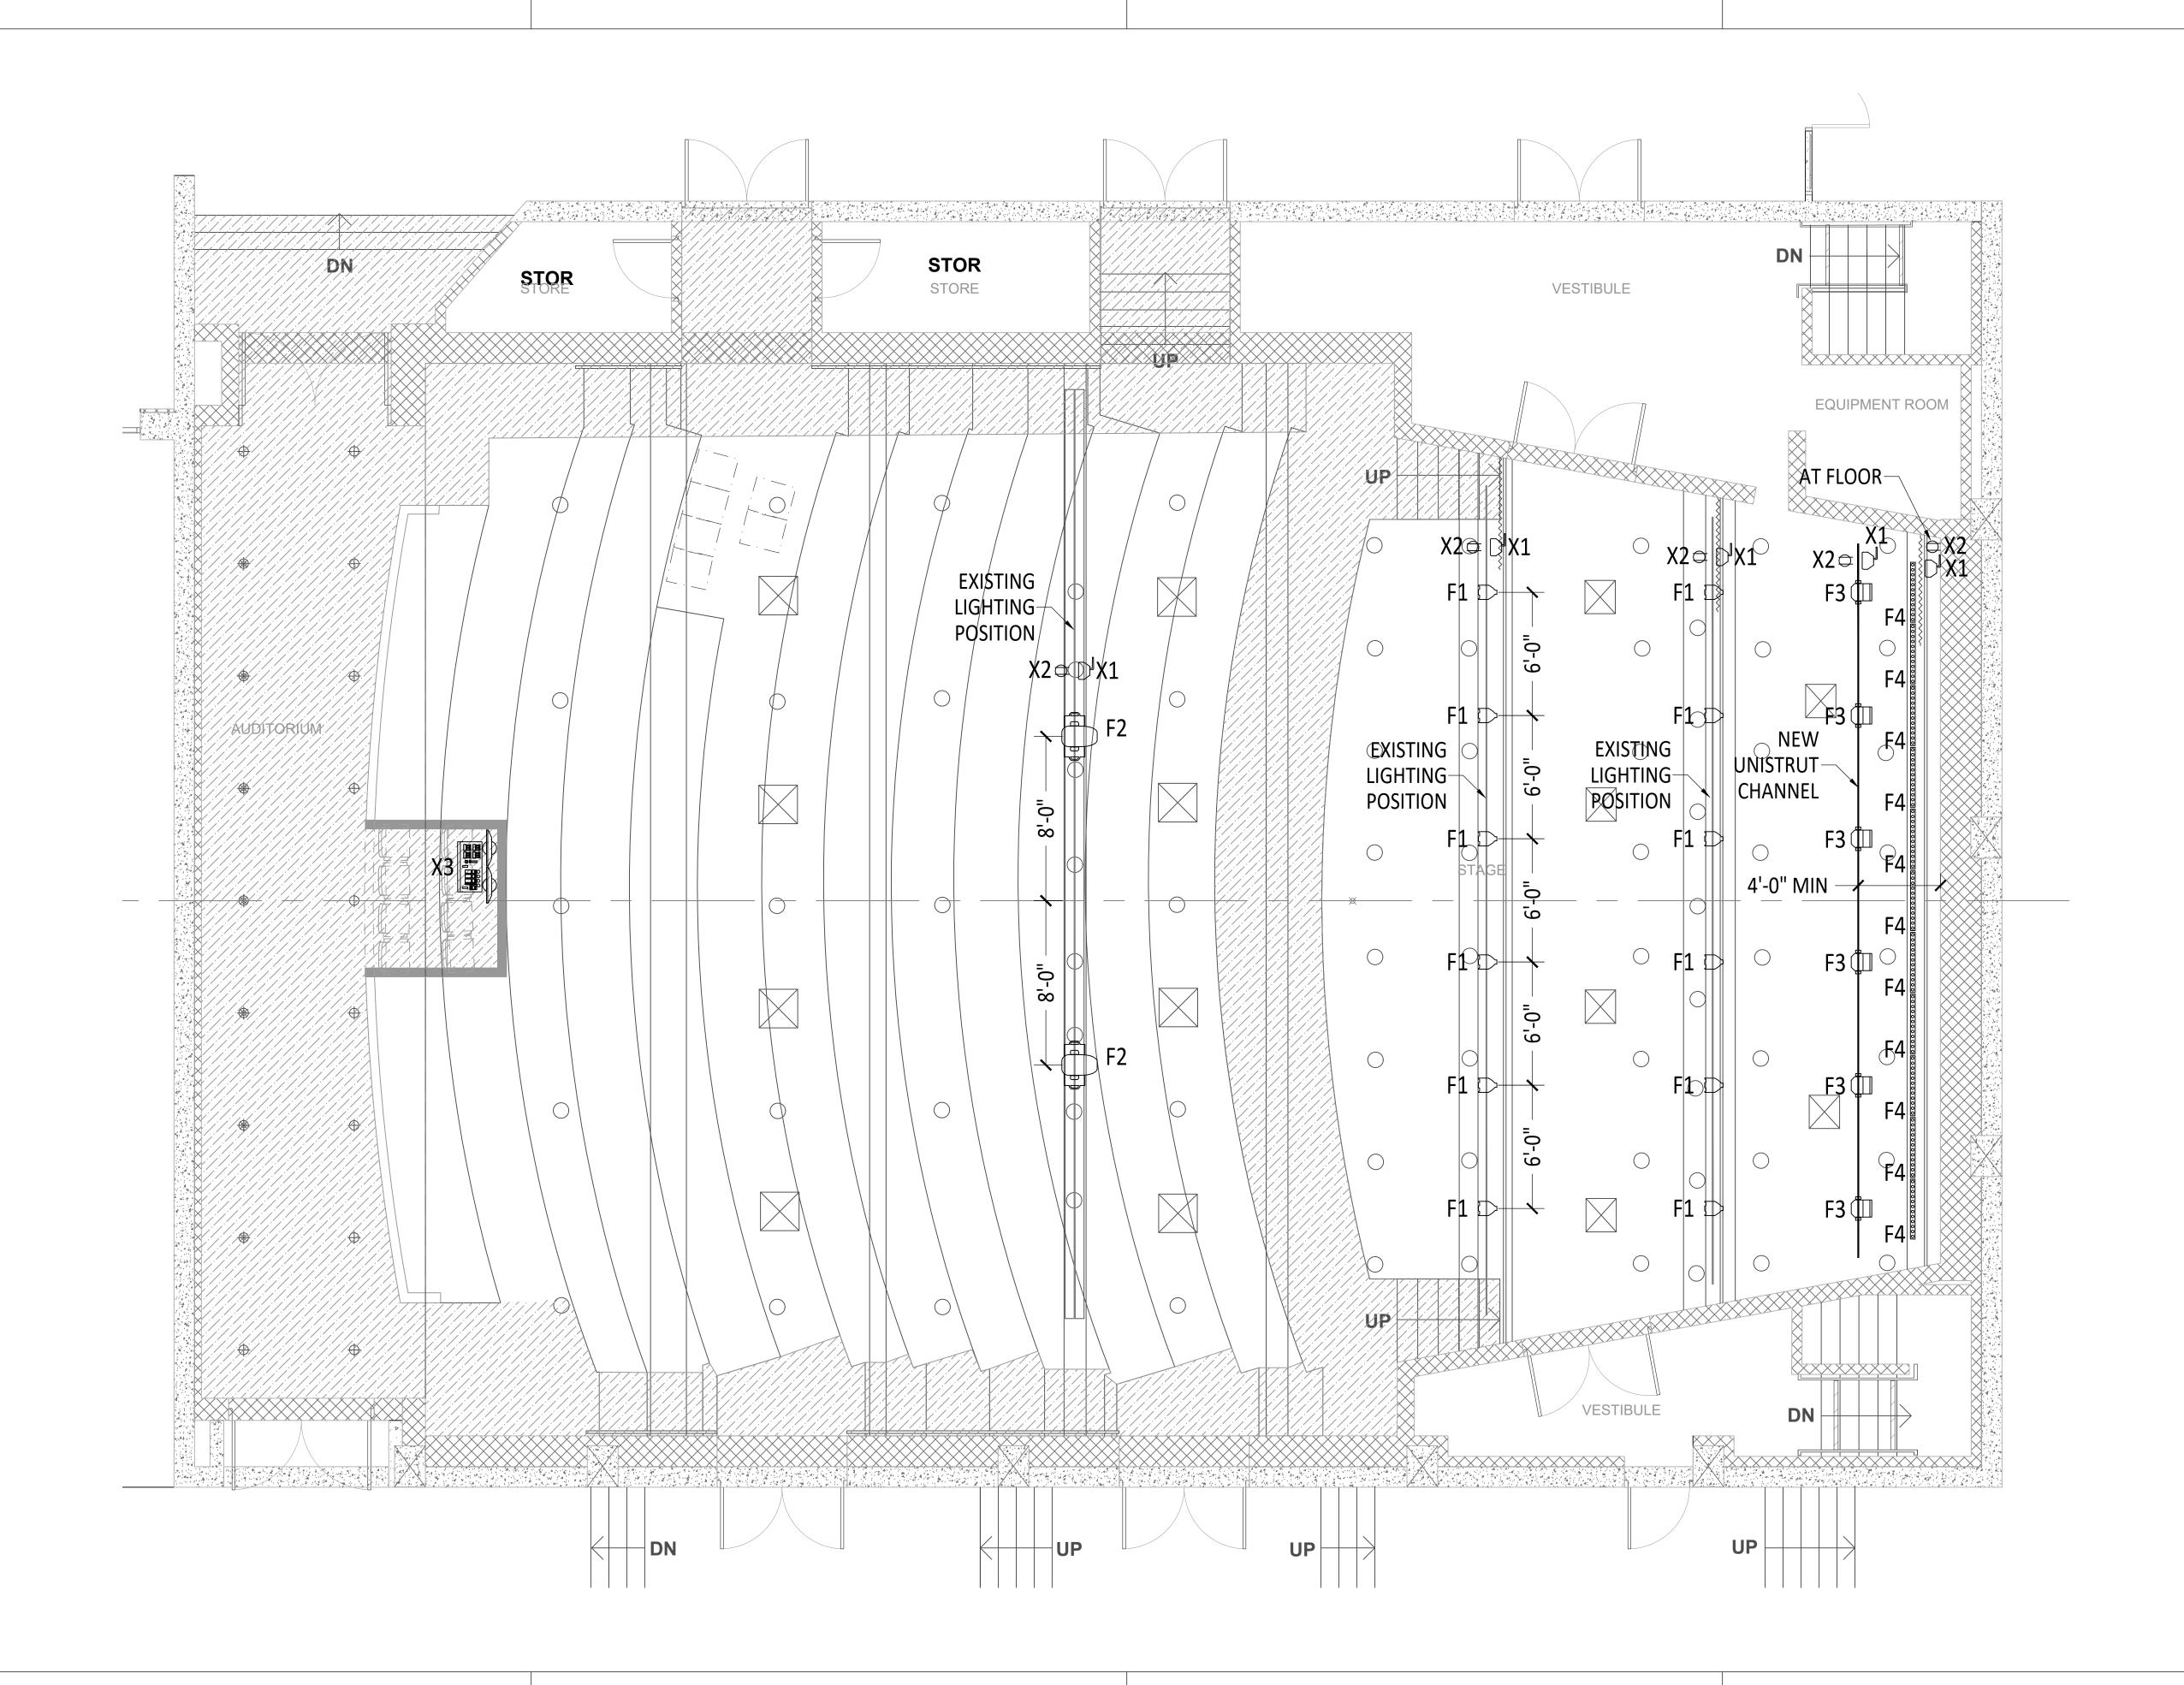

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Consultant

MINUSCULE LIGHTING DESIGN

LYCÉE FRANÇAIS

1201 ORTEGA ST, SAN FRANCISCO, CA 94122

REVISIONS

LIGHTING PLAN

Architect's Project No.

NOVEMBER 15, 2017

Drawn by

Sheet Name

Checked by

Sheet No.

Scale at Original Size - 22" x 34" As indicated

PROJECT SCOPE

- 1. ELECTRICAL FOR THEATRICAL LIGHTING AND AV POWER IN MAIN THEATER.
- 2. REPLACE (E) PANELBOARD WITH NEW PANEL IN THE SAME LOCATION. RE-USE EXISTING CONDUIT BUT UPGRADE FEEDER WIRING AS NOTED.
- 3. NEW RECEPTACLES FOR AV POWER AND LIGHTING.
- 4. NO CHANGES TO GENERAL LIGHTING.
- 5. NO FIRE ALARM WORK.

TABLE OF CONTENTS

SHEET	DESCRIPTION
E0.1	Project Notes and Schedules
E0.2	Electrical Single-Line Diagram
E1.1	Power and Signal Plan - 1st Floor (area of work only)
E1.2	Power and Signal Plan - 2nd Floor (area of work only)

GENERAL NOTES

- DESIGN AND CONSTRUCTION SHALL COMPLY WITH THE 2016 EDITION OF THE CALIFORNIA ELECTRICAL CODE ALONG WITH ALL OTHER LOCAL LAWS AND REGULATIONS REQUIRED BY THE CITY OF SAN FRANCISCO.
- 2. ALL CABLE RUNS ARE SHOWN DIAGRAMMATICALLY ONLY AND SHALL BE RUN TO SUIT CONDITIONS IN THE FIELD. ALL WORK TO BE PERFORMED IN A PROFESSIONAL, WORKMANLIKE MANNER.
- 3. IT IS THE INTENT OF THE DRAWINGS THAT THIS BE A COMPLETE ELECTRICAL INSTALLATION. ANY OMISSIONS OR ERRORS SHALL BE BROUGHT TO THE ATTENTION OF CORISH ELECTRIC AS SOON AS THEY ARE DISCOVERED.
- 4. CORISH ELECTRIC ASSUMES NO RESPONSIBILITY AS A RESULT OF INACCURATE OR ERRONEOUS INFORMATION PROVIDED TO THE FIRM BY CLIENT, GENERAL CONTRACTOR, OTHER ENGINEERS, OR OTHER TRADES IN CONJUNCTION WITH THIS WORK.
- 5. MAINTAIN ALL WORKING CLEARANCES AND DEDICATED EQUIPMENT SPACE AS REQUIRED PER NEC 110.26 THROUGHOUT.
- 6. ALL CONDUCTORS SHOWN TO BE COPPER, THHN (OR SIMILAR), 600V, 90 DEG C INSULATION. SOLID OR STRANDED WIRE MAY BE USED. IF STRANDED WIRE IS USED, ONLY REAR-WIRE DEVICES (OR SIDE-WIRE DEVICES WITH CRIMPED LUGS) ARE ALLOWABLE. ALUMINUM WIRE MAY ALSO BE USED FOR CIRCUITS 50A OR GREATER.
- 7. ALL DEVICES TO BE PROPERLY BONDED TO EQUIPMENT GROUNDING SYSTEM. USE OF SELF-GROUNDING DEVICES IS ACCEPTABLE IF DEVICES ARE UL LISTED AND METALLIC BOXES ARE PROPERLY BONDED.
- 8. ALL WIRING TO BE INSTALLED IN A RACEWAY SYSTEM. MC CABLE OR AC CABLE MAY BE USED IN LIEU OF CONDUIT FOR BRANCH CIRCUIT WIRING WHERE CONCEALED OR WHERE INSTALLED MORE THAN 8' A.F.F. AND USED FOR VIBRATION, FINAL CONNECTION TO LIGHT FIXTURES, OR WHERE FLEXIBILITY IS REQUIRED FOR DEVICES WHICH MAY NEED TO BE RELOCATED. MC MAY ALSO BE USED WITHIN A JOIST BAY TO MAKE TIGHT TURNS INTO JUNCTION BOXES FOR LIGHTING OR POWER.
- 9. TYPE NM CABLE (ROMEX) IS PROHIBITED FROM BEING USED IN ANY MANNER ON THIS PROJECT
- 10. NON-METALLIC RACEWAYS OR CONDUIT SYSTEMS MAY ONLY BE USED FOR SYSTEMS GREATER THAN 50V WHEN INSTALLED BELOW GRADE OR WITHIN CONCRETE (OR SIMILAR) FLOORS AND WALLS. EXPOSED PORTIONS OF BELOW GRADE RUNS (INCLUDING FINAL ELBOWS) MUST BE IN RMC OR IMC CONDUIT (WHEN WIRING CONTAINED WITHIN IS GREATER THAN 50V) UNLESS THE "SWEEP" COMES ABOVE GRADE WITHIN AN EQUIPMENT ENCLOSURE.
- 11. ALL RACEWAYS TO CONTAIN A SEPARATE EQUIPMENT GROUNDING CONDUCTOR SIZED PER NEC 250.122. USE OF CONDUIT AS THE SOLE EQUIPMENT GROUNDING PATH IS PROHIBITED.
- 12. SUPPORT ALL CONDUIT, WIRE, BOXES, AND OTHER DEVICES AS PER NEC REQUIREMENTS FOR THE PARTICULAR WIRING METHOD. USE OF CEILING SUPPORT WIRES FOR ELECTRICAL SYSTEMS IS PROHIBITED. IN SUSPENDED CEILING INSTALLATIONS, IDENTIFY ELECTRICAL SYSTEM SUPPORT WIRES BY USE OF A COLORED TAG OR PAINTED STRIPE ON SUPPORT WIRE.
- 13. WHERE NEW PANELBOARDS ARE SHOWN ON THE DRAWINGS, THEY SHALL BE COMMERCIAL GRADE WITH BOLT-ON BREAKERS (SQUARE-D NQOD SERIES OR EQUAL). LOAD CENTERS ARE ACCEPTABLE FOR RESIDENTIAL UNITS. ADDITIONAL "SNAP-IN" BREAKERS MAY BE ADDED TO EXISTING PANELS SO LONG AS THE ADDITIONAL BREAKERS DO NOT EXCEED 50% OF THE CAPACITY OF THE PANEL. IF MORE THAN 50% OF THE REQUIRED BREAKERS IN AN EXISTING PANEL ARE NEW, THEN PANEL SHOULD BE REPLACED WITH NEW BOLT-ON COMMERCIAL PANEL.
- 14. ELECTRICAL CONTRACTOR TO PROVIDE SUITABLE DISCONNECTING MEANS FOR ALL MOTOR LOADS. ENSURE THAT INSTALLATION COMPLIES WITH NEC. NOTIFY MECHANICAL OR OTHER RESPONSIBLE CONTRACTOR IF AN INSTALLATION IS NOT NEC COMPLIANT. VERIFY THAT OVERLOADS ARE PROPERLY SIZED AND INSTALLED WHERE REQUIRED BY NEC.
- 15. COORDINATE INSTALLATION OF TELEPHONE AND/OR TELEVISION SERVICES IF REQUIRED.
- 16. INSTALL ADDITIONAL "SEISMIC" SUPPORT WIRES FOR LIGHTING FIXTURES. A MINIMUM OF (2) WIRES IS REQUIRED FOR 2x4 OR 2x2 LAY-IN FIXTURES AND (1) WIRE FOR RECESSED FIXTURES SMALLER THAN 2' DIAMETER. NO ADDITIONAL SUPPORT IS REQUIRED IF FIXTURES ARE PROPERLY AND RIGIDLY FASTENED TO THE BUILDING STRUCTURE. TRACK LIGHTING TO BE SECURED TO BUILDING STRUCTURE. TOGGLE OR BUTTERFLY BOLTS MAY ONLY BE USED IN CONJUNCTION WITH A STRUCTURAL SUPPORT
- 17. CIRCUIT NUMBERING DOES NOT INDICATE PHYSICAL ROUTING. CONTRACTOR MAY COMBINE CIRCUITS WITHIN THE SAME CONDUIT AS LONG AS PROPER NEC WIRE FILL AND DERATING PROCEDURES ARE FOLLOWING. CIRCUITS INDICATED WITH A LINE, ARROW, AND DASHES ARE DESIGNATED HOMERUNS AND, IN THESE CASES, NO OTHER CIRCUITS MAY BE COMBINED WITH THE INDICATED CIRCUITS WITHIN THE SAME CONDUIT.
- 18. MULTIWIRE CIRCUITING IS PERMISSIBLE. HOWEVER, THESE CIRCUITS MUST COMPLY WITH NEC 210.4(B) PROVIDE MEANS TO SIMULTANEOUSLY DISCONNECT ALL UNGROUNDED CONDUCTORS.
- 19. CIRCUITS/FEEDERS GREATER THAN 400A MAY BE RUN WITH PARALLEL CONDUCTORS. HOWEVER, NEUTRALS SMALLER THAN 1/0 MAY NOT BE PARALLELED.

SYMBOLS LIST

—————————————————————————————————————	CONDUIT HOM`EL. "LL" IS PANEL NAME/NUMBER, AND "##" IS CIRCUIT NUMBER. HASH MARKS DENOTE QUANTITY OF #12 AWG (OR OTHER GAUGE IF INDICATED) WIRES. NO HASHES DENOTE (1 CONDUCTOR PER PHASE, WITH (1) NEUTRAL, AND (1) GROUND.
LL-#,# (a)	ABBREVIATED CIRCUITING - "LL" IS PANEL NAME/NUMBER, AND "##" IS CIRCUIT NUMBER. "a" IS T SWITCHLEG FOR LIGHTING CIRCUITS.
	CONDUIT RUN, EXPOSED UNLESS INDICATED OTHERWISE
—— IG ——	CONDUIT WITH ADDITIONAL ISOLATED GROUND CONDUCTOR.

#S DISCONNECT SWITCH - GENERAL DUTY, NON-FUSIBLE. "F" INDICATES FUSIBLE. #S = SWITCH SIZE (AMPS), #F = FUSE SIZE (AMPS) (IF FUSIBLE). "HD" INDICATES HEAVY-DUTY. NUMBER OF POLES AS SPECIFIED OR EQUAL TO NUM OF PHASE CONDUCTORS IF CIRCUIT #'S ARE INDICATED. NEMA 1 ENCLOSURE FOR INDOORS AND NEMA 3R ENCLOSURE OUTDOORS, U.O.N.

CIRCUIT BREAKER. #F = FRAME SIZE (AMPS), #T = TRIP SETTING (AMPS)

PANELBOARD. FLUSH OR SURFACE MOUNTED AS SHOWN ON PLANS AND PANEL SCHEDULES. ADJACENT BALLOON INDICATES PANEL DESIGNATION.

JUNCTION BOX IN ACCESSIBLE OR OPEN CEILING SPACE. SIZE AS REQUIRED. WEATHERPROOF WHEN OUTDOORS.

(I) WALL JUNCTION BOX +18" U.O.N. PURPOSE TO BE DEFINED BY NOTES. WEATHERPROOF WHEN OUTDOORS.

SAME AS ABOVE EXCEPT DOUBLE DUPLEX IN COMMON BOX

ELECTRIC MOTOR AND HP RATING (NUMERAL).

SPECIAL PURPOSE RECEPTACLE - CEILING MOUNTED ON DROP CORD OR IN FLOOR IF NOTED. SEE NOTATION ADJACENT TO SYMBOL FOR MORE INFORMATION.

FLUSH CEILING MOUNTED BOX WITH NEMA 5-20R DUPLEX RECEPTACLE. 125V, 2P, 3W, 20A.

SPECIAL PURPOSE RECEPTACLE - WALL MOUNTED. SEE NOTATION ADJACENT TO SYMBOL FOR MORE

FLOOR POWER AND/OR DATA FEED (FLUSH IN-FLOOR BOX)

FLOOR POWER AND DATA FEED (INTO MILLWORK - NOT AN IN-FLOOR BOX)

ELECTRIFIED FURNITURE BASE FEED. WALL MOUNTED IF INDICATED WITH "TICK" OR FLOOR
MOUNTED IF NOT. PNL-# INDICATED PANEL AND POWER CIRCUITS, D# INDICATES NUMBER OF DATA
CABLES (OR CONDUIT SIZE IF ROUGH-IN ONLY). CABLING TYPE TO BE INDICATED ON SHEET.

\$ab FLUSH WALL TOGGLE SWITCH . 20A., 120V. - SUBLETTERS DENOTE ITEMS CONTROLLED. @+42"U.O.N.

20A FLUSH WALL THREE-WAY SWITCH - SUBLETTERS DENOTE ITEMS CONTROLLED @ +42" U.O.N.

TWO POLE MOTOR RATED TOGGLE SWITCH.(250V.)

Sm SINGLE POLE MOTOR RATED TOGGLE SWITCH.(125V.)

(S) CEILING MOUNTED OCCUPANCY SENSOR - LINE OR LOW VOLTAGE

S WALL MOUNTED OCCUPANCY SENSOR - LINE VOLTAGE

MS EXTERIOR MOTION SENSOR - WEATHERPROOF (LINE OR LOW VOLTAGE AS NEEDED)

SB #2 LOW VOLTAGE SWITCHBANK - SEE NOTES OR SCHEDULE FOR SWITCHLEG'S CONTROLLED FROM THIS LOCATION.

 $\overline{AC-1}$ MECHANICAL EQUIPMENT DESIGNATION. VERIFY EXACT LOCATION WITH MECH/PLUMBING PLANS.

DUCT SMOKE DETECTOR IN RETURN AND SUPPLY AIR DUCTS WITH SAMPLING TUBE. FURNISHED & INSTALLED BY HVAC CONTRACTOR, WIRED BY E.C.

TELEPHONE OR DATA OUTLET, FLUSH @+18"U.O.N. PROVIDE 3/4" C.O. TO +6" ABOVE ACCESSIBLE CEILING SPACE OR CABLING IF INDICATED IN EC'S SCOPE.

COMBINATION TELEPHONE/DATA OUTLET, FLUSH @+18"A.F.F. (U.O.N.). PROVIDE 3/4" C.O. TO +6" ABOVE ACCESSIBLE CEILING SPACE OR CABLING IF INDICATED IN EC'S SCOPE.

THERMOSTAT. PROVIDE & INSTALL 3/4"C.O. TO ACCESSIBLE CEILING SPACE. REFER TO MECH DRAWINGS FOR EXACT LOCATIONS.

(E) EXISTING TO REMAIN
(N) NEW ITEM / DEVICE

(R) EXISTING TO BE RELOCATED
(RM) EXISTING TO BE REMOVED

MLO MAIN LUGS ONLY

NL NIGHT LIGHT (24 HR) FIXTURE

NL/EM NIGHT LIGHT (24 HR) FIXTURE WITH 90-MIN BATTERY BACKUP

FIXTURE WITH 90-MINUTE EMERGENCY BATTERY BACKUP

EM FIXTURE WITH 90-MIN
WP WEATHERPROOF

NTS NOT TO SCALE

C.O. CONDUIT ONLY WITH PULL WIRE

OUN UNLESS OTHERWISE NOTED

ISOLATED GROUND DEVICE

HG HOSPITAL GRADE DEVICE
N/F NON-FUSIBLE

EC ELECTRICAL CONTRACTOR

GFI or GFCI GROUND FAULT INTERRUPTER
AFI or AFCI ARC FAULT INTERRUPTER

NIC NOT INCLUDED (IN SCOPE OR CONTRACT)

NOTE: All electrical switches and receptacles must comply with CBC 1117B.6(5) as follows: 5. Installation heights of electrical switches and receptacle outlets.

- 5.1. Electrical switches. Controls and switches intended to be used by the occupant of the room or area to control lighting and receptacle outlets, appliances or cooling, heating and ventilating equipment, shall be located no more than 48 inches (1219 mm) measured from the top
- platform.
 5.2. Electrical receptacle outlets. Electrical receptacle outlets on branch circuits of 30 amperes or less and communication system receptacles shall be located no more than 48 inches (1219 mm) measured from the top of the receptacle outlet box or receptacle housing nor less than 15

of the outlet box nor less than 15 inches (381mm) measured from the bottom of the outlet box to the level of the finish floor or working

inches (381 mm) measured from the bottom of the receptacle outlet box or receptacle housing to the level of the finish floor or working platform.

Does not apply to floor/ceiling devices, appliance receptacles, HVAC equipment and other similar loads.

Life Safety Non-Infringement Statement:

It is the design professional's judgment, whose signature appears on these drawings, that the design described in the set of drawings and specifications does not adversely infringe upon the basic life safety systems of the building.

CORISH ELECTRIC

P.O. BOX 812 MILLBRAE, CA 94030 PHONE (415)626-1885 FAX (650)239-3618 LICENSE #833233

PROJECT: LSSF 1201 Ortega St, San Francisco, CA


PANELBOARD SCHEDULE - AV

LD C/B P NO A LOAD B NO C/B P DESCRIPTION TYP	RECE	ESSED MOUNTED 10KAIC	1Ф,	3W		240∆/12	20V, 100A	4	MAI	NS: MI	_O	Fed from 15KVA Transformer T3A	
Receptacle 20	LD				CIR				CIR				
Wireless DMX at Gantry	TYP	DESCRIPTION	C/B	Р	NO		LOAD	В	NO	C/B	Ρ	DESCRIPTION	TYP
Projector		Receptacle	20	1	1	700						Receptacle	
Projector		Wireless DMX at Gantry				1000			2	20	1	Wireless DMX above Stage	
Cord Reel			20	2	3			850				Receptacle	
Receptacle 20 1 7 1000 8 20 1 Receptacle Cord Reel 20 1 9 360 1200 8 20 1 AV Equipment Receptacle Control Booth 20 1 13 14 20 1 Receptacle AV Equipment Receptacle Control Booth 13 14 20 1 AV Equipment Receptacle Control Booth 15 16 20 1 AV Equipment Receptacle Control Booth 15 16 20 1 AV Equipment Receptacle Control Booth 15 16 20 1 AV Equipment Receptacle Control Booth 15 16 20 1 AV Equipment Control Booth 17 18 20 1 AV Equipment Control Booth 19 20 20 1 AV Equipment Control Booth 21 22 20 1 AV Equipment Control Booth 22 20 1 AV Equipment Control Booth 22 20 1 AV Equipment Control Booth 23 24 20 1 AV Equipment Control Booth 25 26 20 1 AV Equipment 25 26 26 26 26 26 26 26		Projector						1120	4	20	1	Wireless DMX above Stage	
Receptacle		Cord Reel			5	850						Receptacle	
Cord Reel						1250			6	20	1	Wireless DMX at Stage floor	
Receptacle		Receptacle	20	1	7			1000				Receptacle	
Control Booth 1200 10 20 1 AV Equipment Receptacle 20 11 720 1200 12 20 1 AV Equipment Receptacle 1200 12 20 1 AV Equipment Receptacle 1200 12 20 1 AV Equipment Receptacle 1300 14 AV Equipment Receptacle Rece		Cord Reel						1200	8	20	1	AV Equipment	
Receptacle		Receptacle	20	1	9	360						Receptacle	
Control Booth		Control Booth				1200			10	20	1	AV Equipment	
13		Receptacle	20		11			720				Receptacle	
15		Control Booth						1200	12	20	1	AV Equipment	
15					13								
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19					17								
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21					19								
									20	20	1		
23					21								
24 20 1 25 26 20 1 27 28 20 1									22	20	1		
25					23								
26 20 1 27 28 20 1									24	20	1		
27					25								
29 30 20 1 TOTAL VA PER PHASE 5360 0 6090 25% CONTINUOUS LOAD 0 25% LARGEST MOTOR 0 TOTAL CALCULATED VA 11,450									26	20	1		
29 30 20 1 TOTAL VA PER PHASE 5360 0 6090 25% CONTINUOUS LOAD 0 25% LARGEST MOTOR 0 TOTAL CALCULATED VA 11,450					27								
TOTAL VA PER PHASE 5360 0 6090 25% CONTINUOUS LOAD 0 25% LARGEST MOTOR 0 TOTAL CALCULATED VA 11,450									28	20	1		
TOTAL VA PER PHASE 5360 0 6090 25% CONTINUOUS LOAD 0 25% LARGEST MOTOR 0 TOTAL CALCULATED VA 11,450					29								
25% CONTINUOUS LOAD 0 25% LARGEST MOTOR 0 TOTAL CALCULATED VA 11,450										20	1		
25% LARGEST MOTOR 0 TOTAL CALCULATED VA 11,450							0	6090					
TOTAL CALCULATED VA 11,450						0							
						-							
TOTAL AMPS 45 0 51													
		TOTAL AMPS				45	0	51					

1 PANEL SCHEDULES
SCALE: NTS

Lycee Fancais School

1201 Ortega St. San Francisco, CA 94122

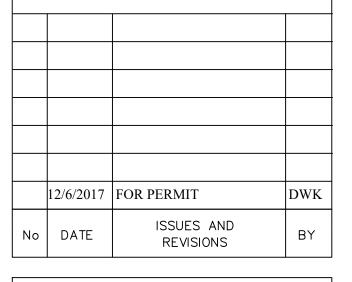

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SHEET TITLE :


Electrical Notes and Schedules


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Scale NTS

Date 12/6/20


Drawn by 12/6/2017



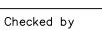
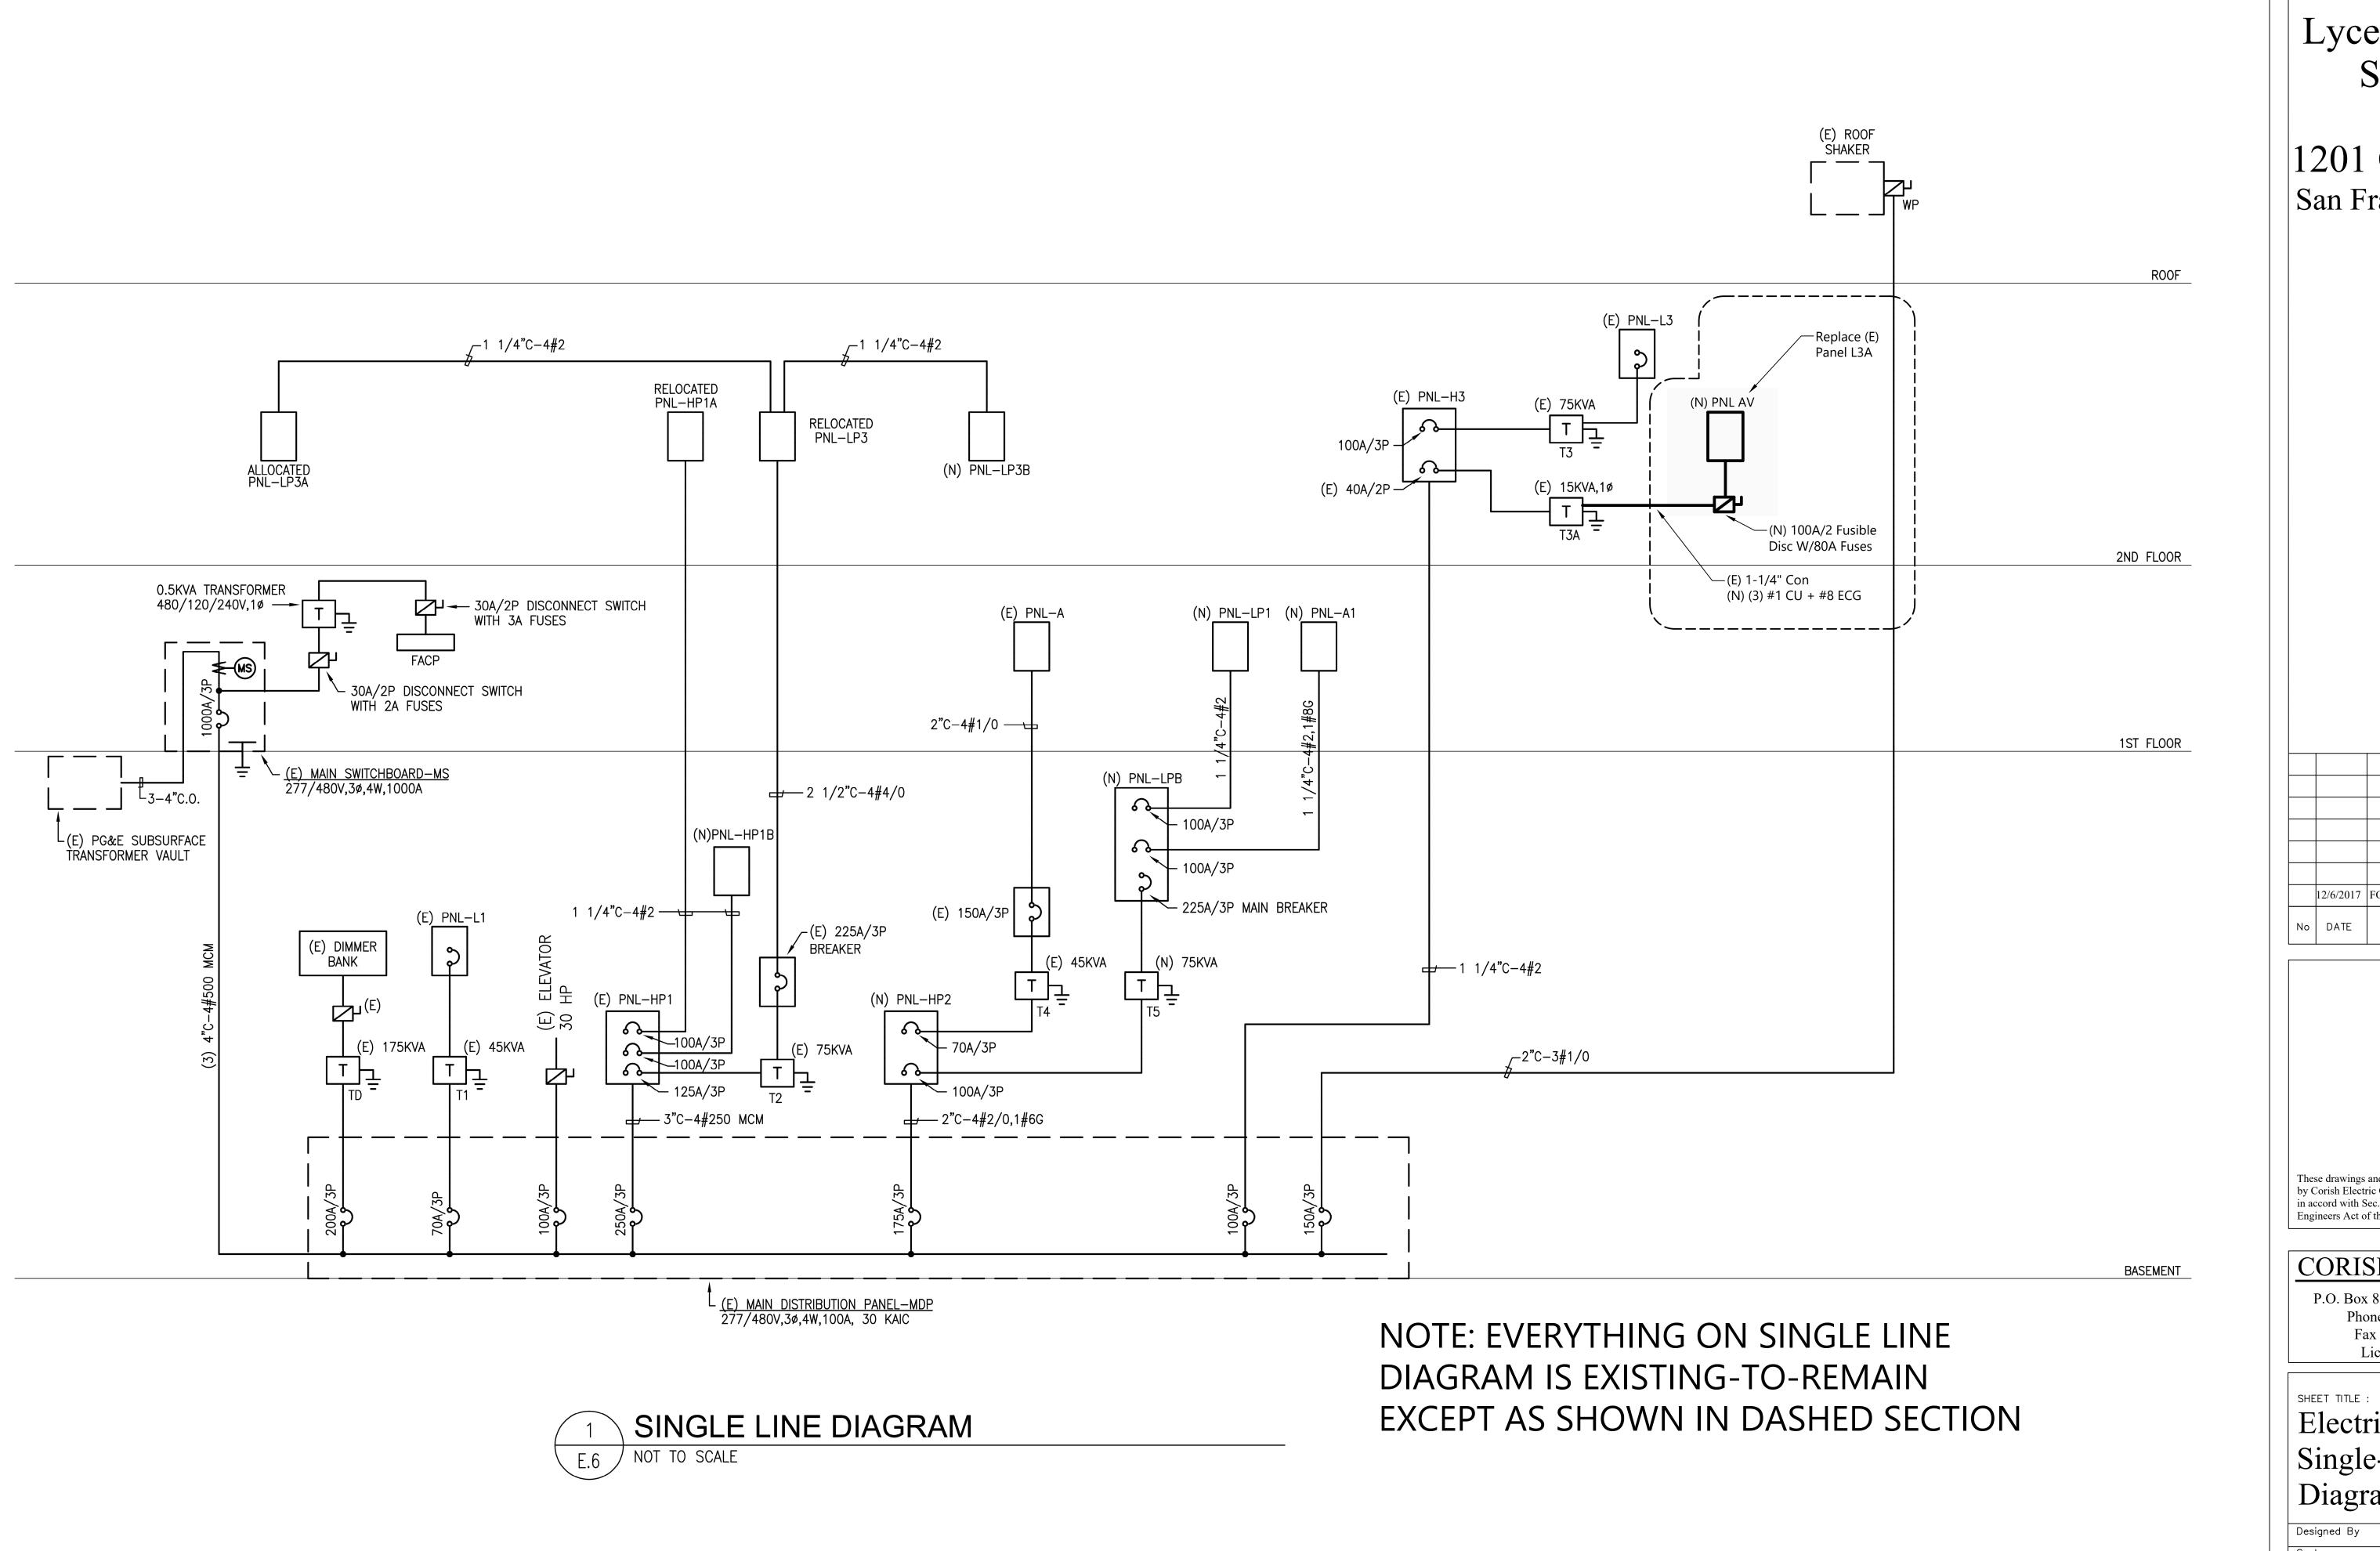
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Electrical Single-Line Diagram


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12/6/2017
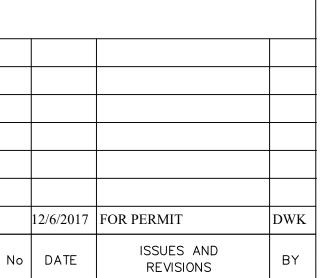
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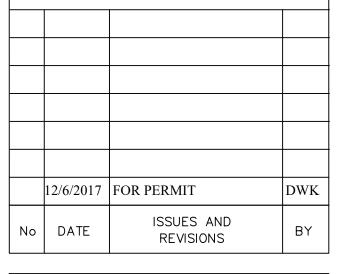
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SHEET TITLE :

Electrical Plan
Partial 1st Floor


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Scale 1/4" = 1'

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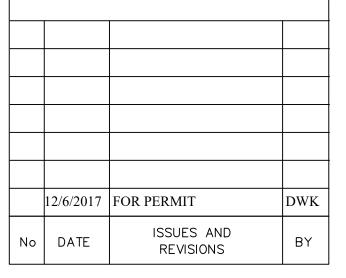
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SHEET TITLE :

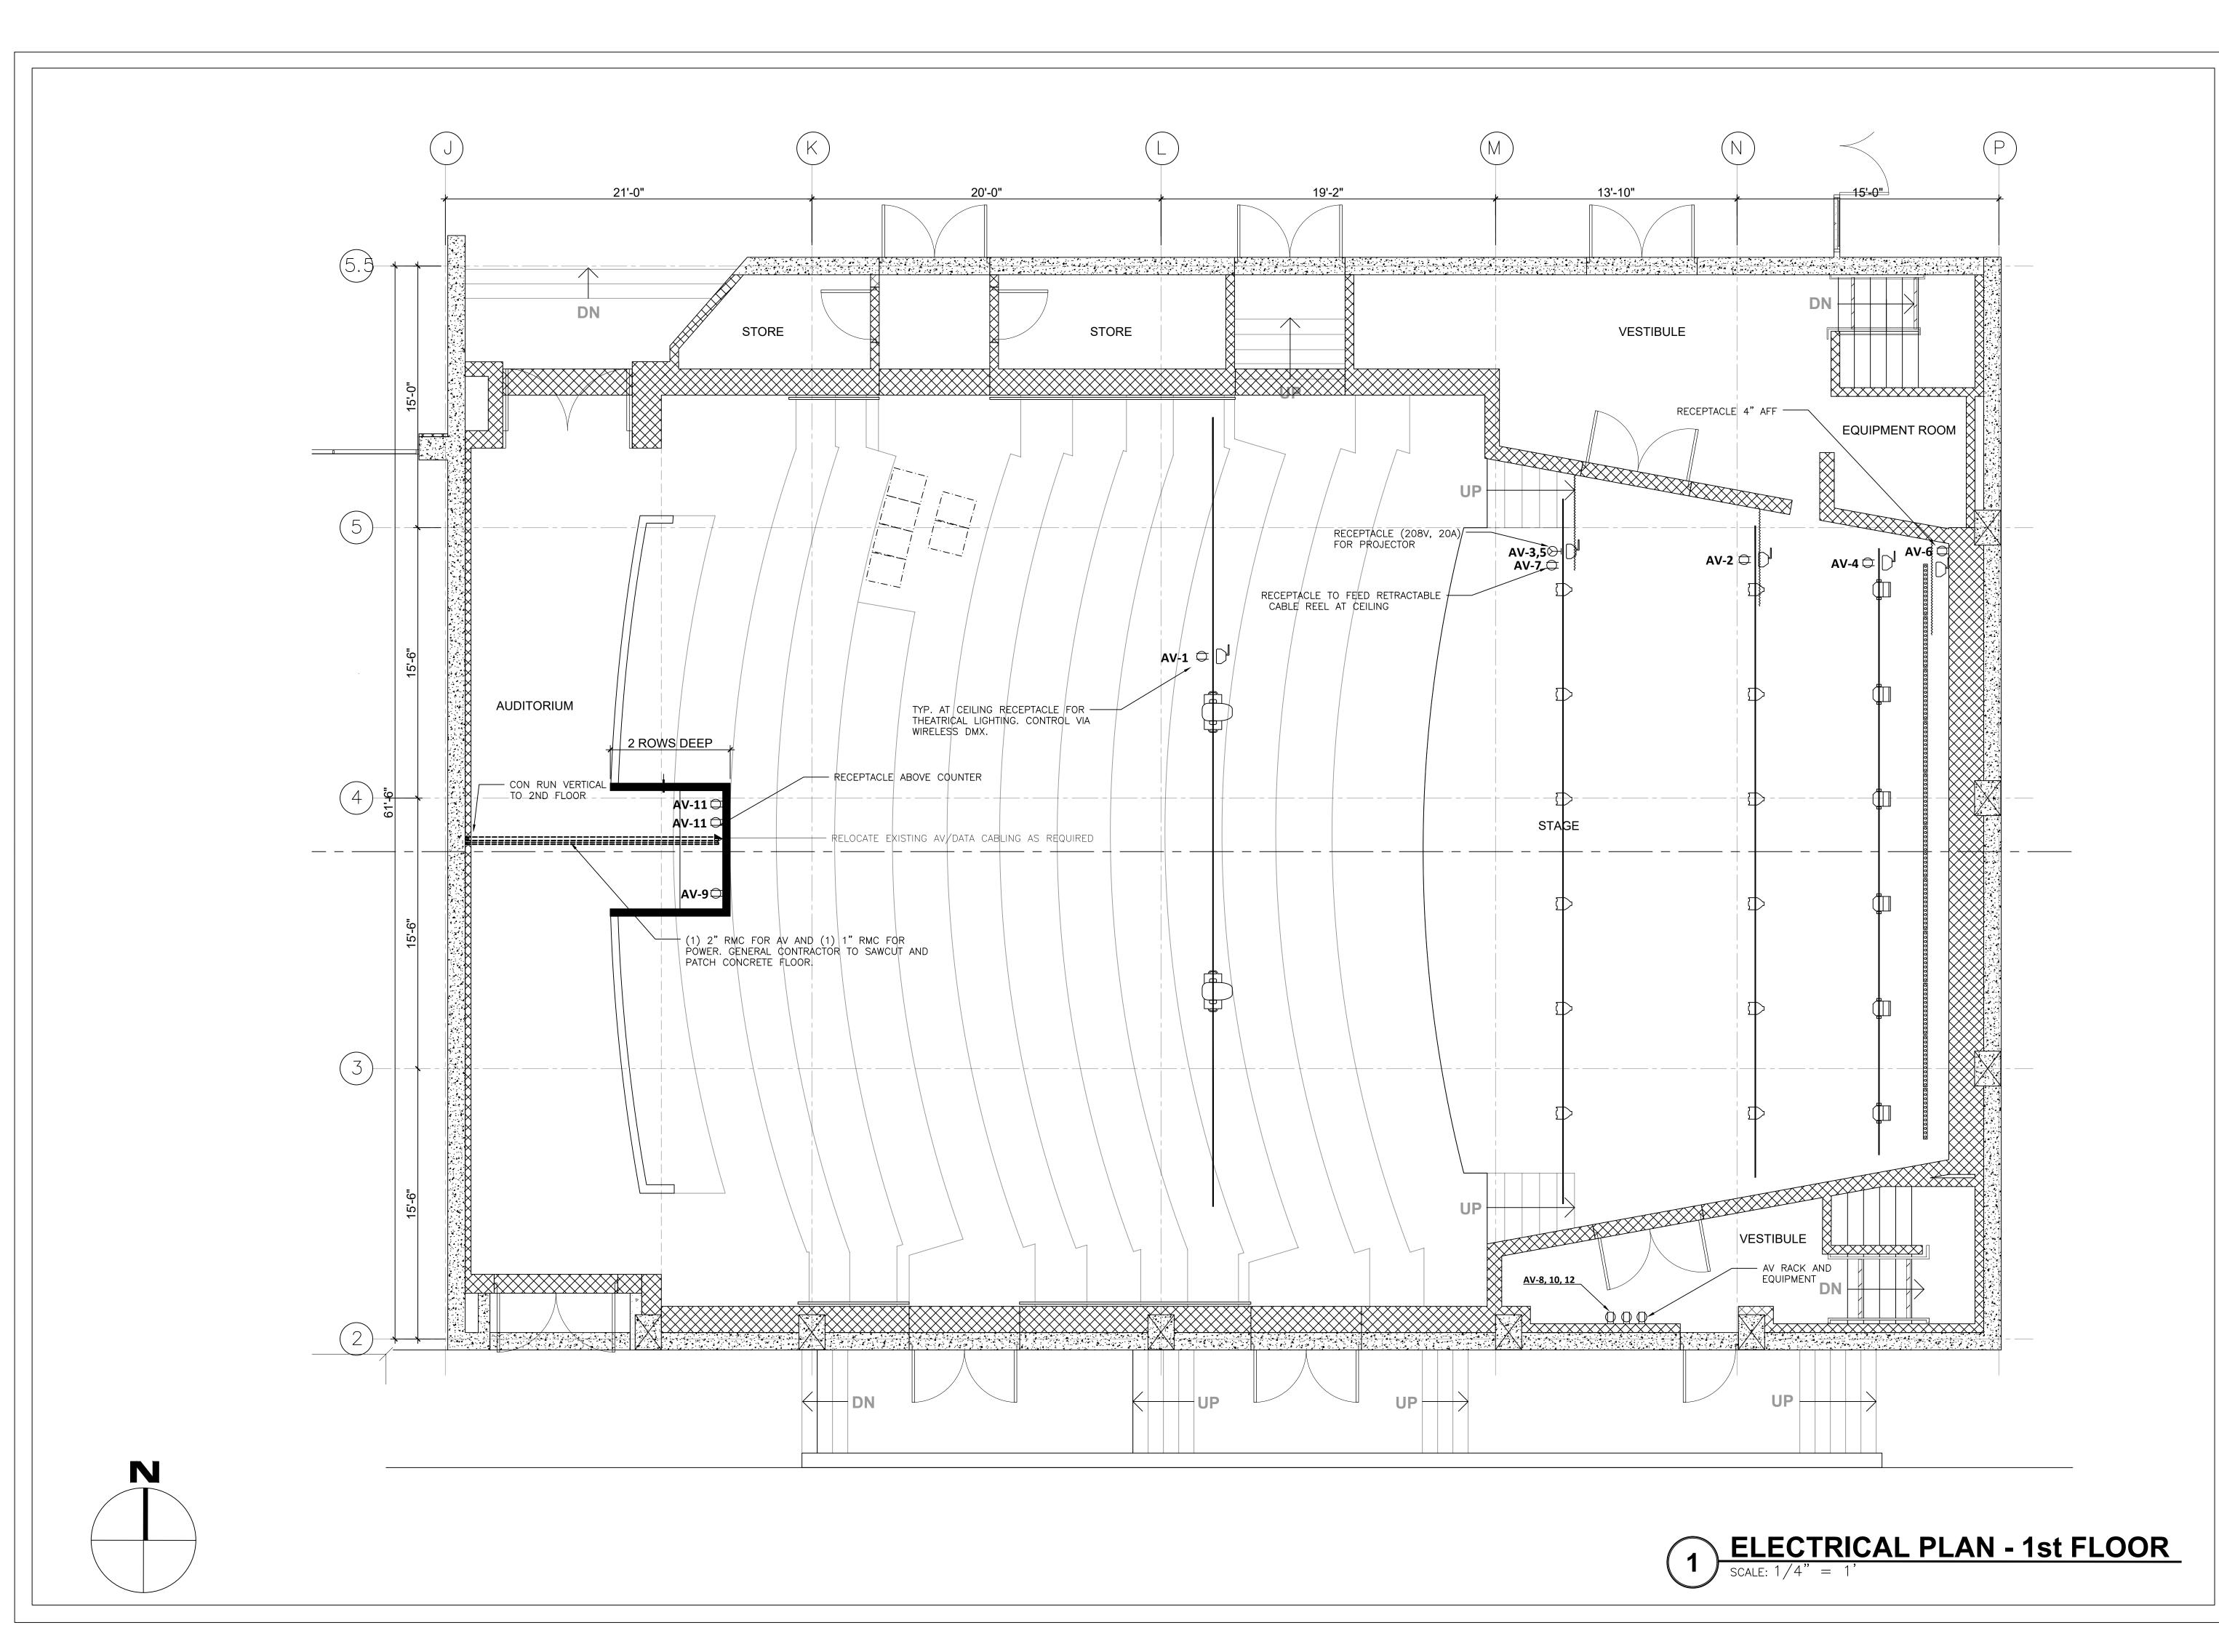Electrical Plan
Partial 2nd Floor

Designed By DWK sheet no.

Scale 1/4" = 1'

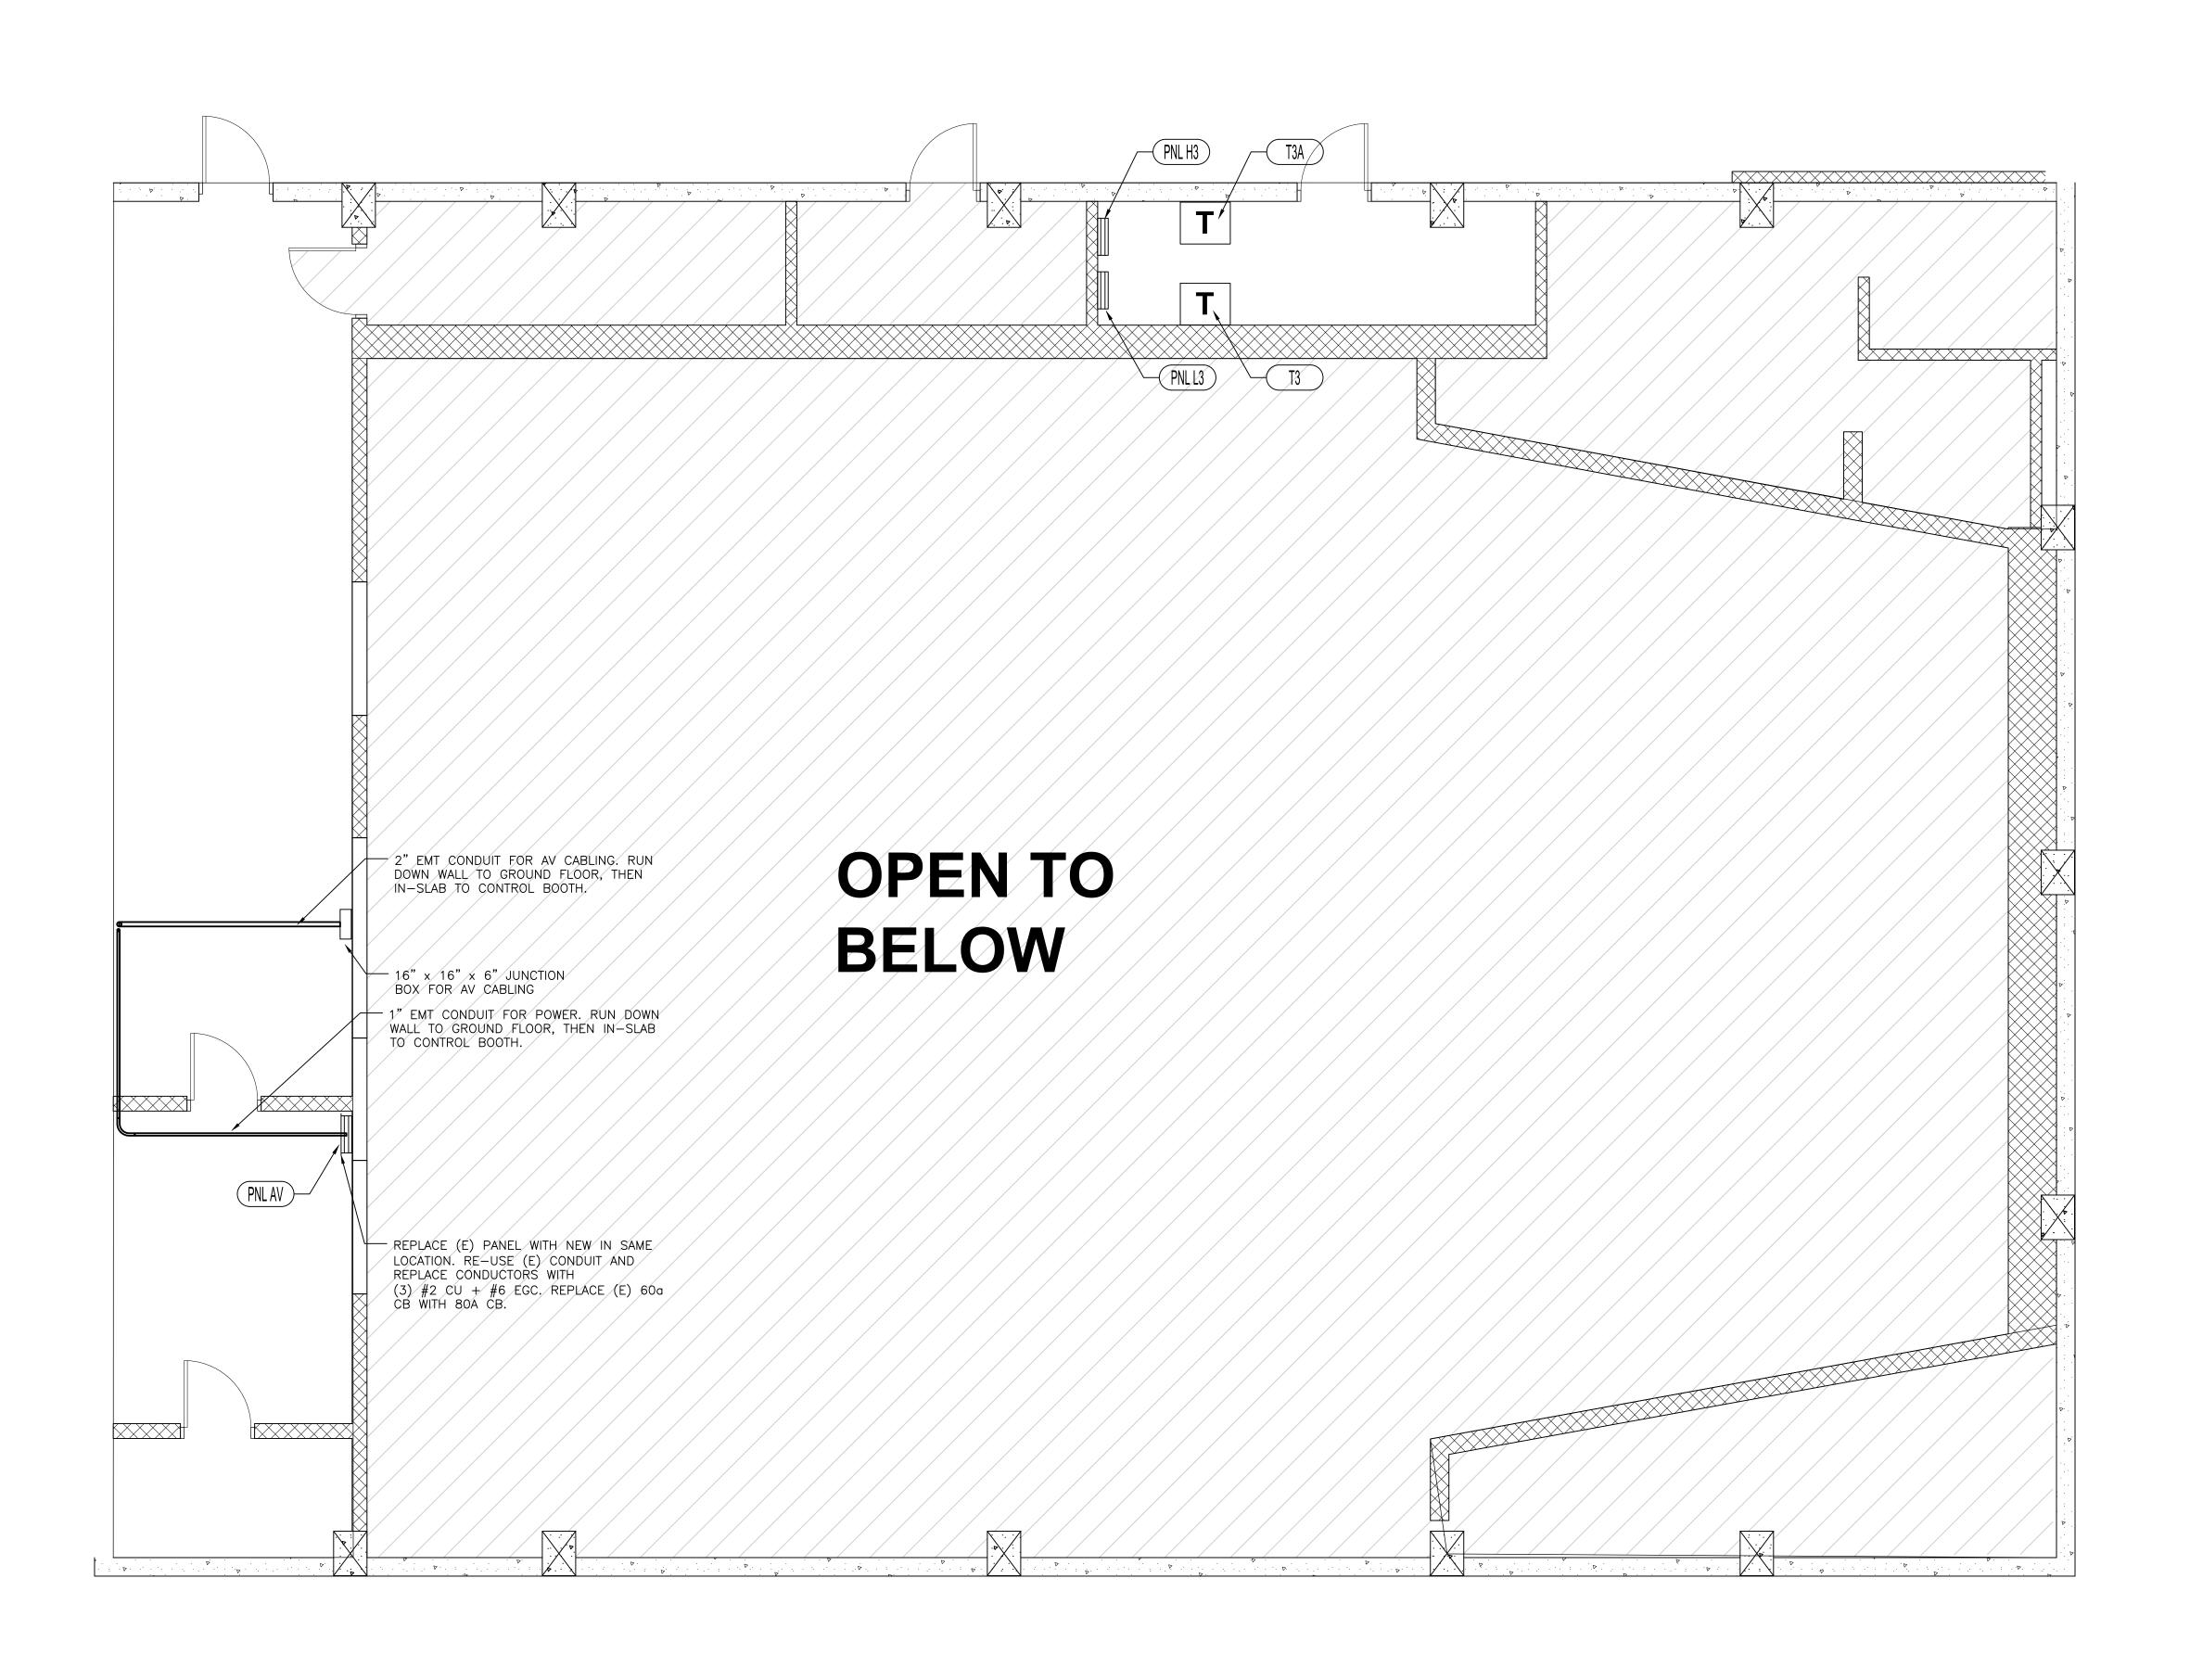Checked by

 $_{ ext{Date}}$ Drawn by

